6-10 Orr Street - AR109526

6-10 Orr Street Netherby Ashburton, 7700

No.	Name	Current Revision
0-00.00	Cover Sheet	A
0-11.01	Existing Site Plan	A
0-11.02	Axonometric View	A
0-11.03	Bulk and Location Plan - Ground Floor	В
0-11.04	Bulk and Location Plan - First Floor	В
0-16.01	General Arangement Elevations	В
0-16.02	General Arangement Elevations(Internal)	В
0-16.03	Shading Diagrams - Winter & Summer	A
0-16.07	Shading Diagrams- Spring & Fall	A





Resource Consent

Hierarchy Group.

Issue Date: 19/03/2024

Drawn By: KTC Checked By: MG

Scale: @ A1 Project No: H1259-117

Sheet Name:
Cover Sheet

DP 18886 DP 18886 Lot 2 DP 538661 DP 18886 Existing Neighbour's tree be to tramed — Part Lot 18 Lot 6 DP 18886 Lot 1 DP 12642 Lot 2 DP 12642 1 Existing Site and Demolition Plan

GENERAL DEMOLITION NOTES

The demolition drawings are to be read in conjunction with the relevant specification sections.

 All demolition work is to be carried out in accordance with NZDAA best practice guidelines for demolition.

with NZDAA best practice guidelines for demonstr

 All demolition work is to be carried out in accordance with any of the local council conditions. The main contractor is to check and verify conditions that may apply prior to the commencement of demolition.

5. The words 'demolish' and 'demolition' means to pull or knock down and clear off the site completely the parts of the building required to be pulled or knocked down.

Ensure all existing services are located and identified prior to commencing demolition. All services that are not required to be maintained during the demolition work shall be properly disconnected and sealed off before any demolition work commences.

 Remove all redundant services associated accessories/cap/make good all redundant drainage

8. Additional demolition work may be required to be carried out that has not been identified in red in the demolition drawings in order to construct the new works. The tenderer/contractor to visit the site to confirm the exact scope of demolition work required to be carried out and any additional work is to be included in the tender price. The demolition drawings are to be read in conjunction with the drawings associated with the proposed works.

 Contractor to notify superintendent immediately in the event of finding materials suspected to contain asbesto

10. Security fences shall be provided and all required precautionary measures taken as may be necessary to prevent unauthorized entry to the demacated area of works. Notices displaying the words 'DANGER DEMOLITION IN PROGRESS or similar shall be be fixed to the fencing at appropriate places to warm the public. Provision shall be made for ready access to the site by emergency services personnel in the event of fire or accident. Contractor to confirm precautionary measures prior to commencement of demolition.

The effects of vibration and dust shall be minimized, as far as practicable, by selecting demolition methods and equipment appropriate to the circumstances.

12. No part of any structure shall be left unsupported or unattented in such a condition that it may collapse or become dangerous. Precautions shall be taken to ensure that the stability of all parts of the structure and the safety of persons on and outside the site will be maintained in the event of sudden and severe weather changes.

13. Walls shall not be laterally loaded by accumulated debris or rubble, to the extent that they are in danger of collapse.14. Dust generated during stripping, or during the

or can be otherwise contained.

15. Precautions shall be taken to minimize the spreading of mud and debris by vehicles entering and leaving the site. Contractor yo take adequate measures to minimize noise levels as part of the construction process.

noise levels as part of the construction process.

16. The exact extent of landscaping (both hard (concrete etc.) and soft (vegetation etc.) to be demolished or cut down and removed from site is to be determined on site. The extent of the hard landscaping is to be determined on site. The extent and quantum indicated on this drawing is indicative.

DEMOLITION LEGEND

Extent of building demolition

Extent of paving demolition

Extent of vegetation removed

SURVEY DISCLAIMER


This drawing has been prepared by Graham Surveying Limited solely for the benefit and use by our client in accordance with the terms of our engagement and client instructions.



Ashburton, 7700

Revision Schedule

Description
Resource Consent

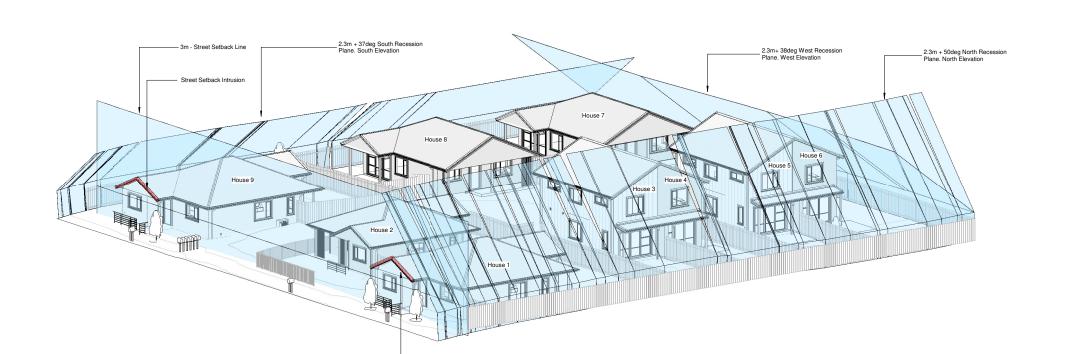

2. Axometric View - 2
Sow of All

3. Axometric View - 2
Sow of All

4. Axo

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Axometric View - 1



6-10 Orr Street - AR109526

Address: 6-10 Orr Street
Netherby
Ashburton, 7700

H1259-117

Revision Schedule

Description
Resource Consent


Axonometric View

Sheet No: 0-11.02

COMPLIANCE WITH RECESSION PLANES
House 1 No, Eaves Intrusion with Street setback
House 2 Yes

House 2 Yes
House 3&4 Yes
House 5&6 Yes
House 7 No, Gutter Intrusion with yard setback
House 8 Yes


Recession Planes

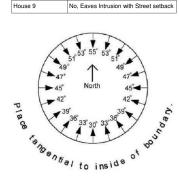


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SCALE SUMMARY

UUU	J W MI	= 2000	W AS	100	@ A I	= 200	W AS
500	@ A1	= 1000	@ A3	50	@ A1	= 100	@ A3
250	@ A1	= 500	@ A3	25	@ A1	= 50	@ A3
200	@ A1	= 100	@ A3	10	@ A1	= 20	@ A3
50	@ A1		@ A3	5	@ A1	= 10	@ A3



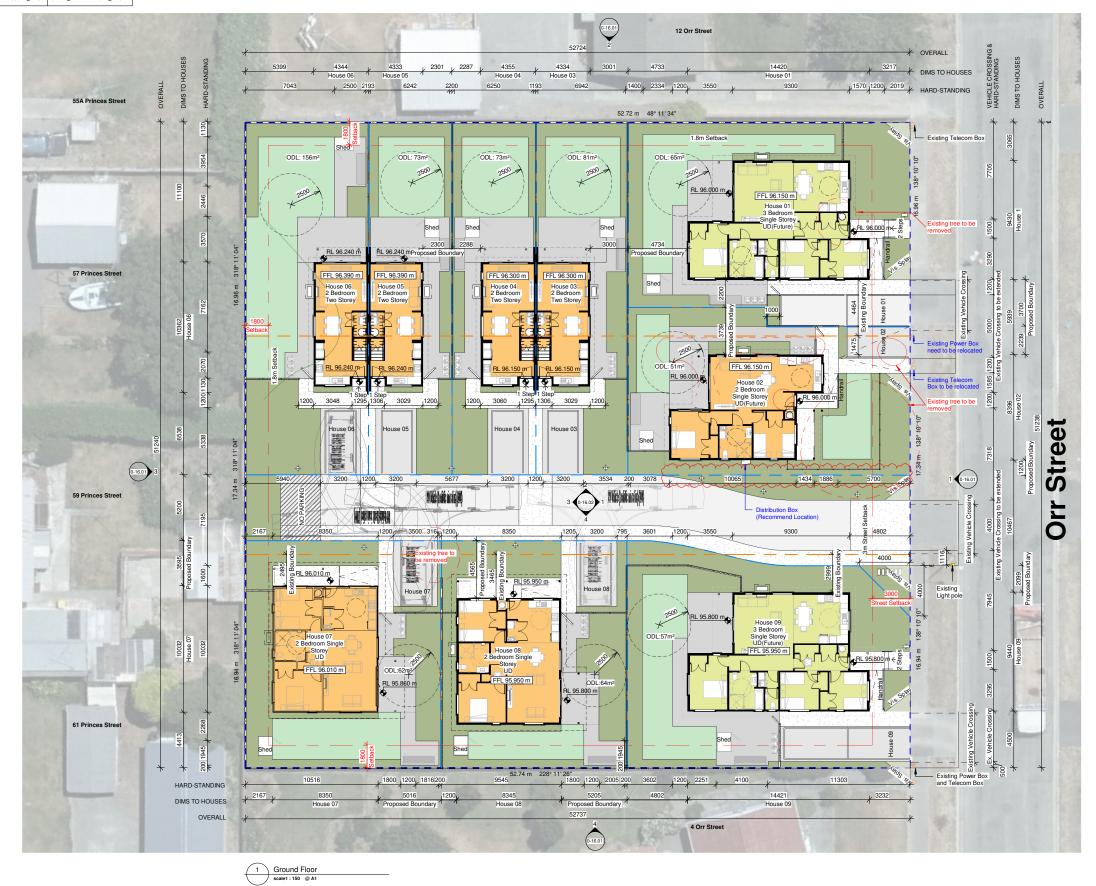

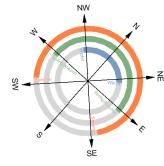	LEGAL DESCRIPTION				
	Address:	6-10 On Ashburt		et, Netherby,	
	Lot / DP / CB	3/4/5	/	18886	
	ZONING INFO:				
	Wind Region:			Α	
	Earthquake Zone	:		1	
	Exposure:			В	
	Wind Zone:			Medium	
i	Planning Zone:			RC	
	Flood Manageme	nt Zone:		NA	

All dimensions are nominal and are to be checked on site before commencing work.

Location of water supply, power & phone to be confirmed

LINE TYPES LEGEND				
	Site Boundary			
	Existing Boundary			
	New internal Boundary			
	Setbacks			
	Handrail			

Exposed aggregate Finishes to be crushed aggregate and compliant with Slip Resistance requirements of D1

Timber Entry Decks
To be coated with Dulux Intergrain UltraDeck, Slip
Resistant, Achieving a P4 Slip resistance rating in
compliance with D1 2.1.5

HANDRAILS AND RAMPS NOTES

All external steps for FUD to have a maximum riser of 180mm and a minimum tread of 310mm with a clear width of 1200mm, and have the ability to install handrails in the future if required. All steps will require handrails where the change in level is more than 500mm high.

Accessible ramps are to be set at a maximum slope of 1:12 with a clear width of 1200mm.
Where the surface of an accessible route is more than 25mm above the adjacent ground, protection is to be provided by a 75 mm high ramp edge.

Handrails to be 1.1m high Juralco Viking balustrade system

	MASTERPLANNING LEG
	1 Bedroom House:
	2 Bedroom House:
	3 Bedroom House:
	4 Bedroom House:
	5 Bedroom House:
]	Driveway:
	Footpath:
	Lawn Area:

Landscaping: Waste & Recycle Areas: Refuse Bins: Washlines 1 & 2 Bed: 1,2m above FFL (940mm x 2490mm) WM Lighting Bollard

Small Shed 1 Bed = (1530W x 785D x 1830H mm)
* For no lawn unit only Medium Shed 1 - 4 Bed = (1530W x 1080D x 1830H mm)

 Φ

Large Shed 5 - 6 Bed = (1530W x 1830D x 1930H mm)

BULK & LOCATION

Address:	6-10 Orr Street, Netherby, Ashburton		
Total Site Area:	2702 m ²		
	Net Lot Area	Net Lot Site Coverag	
House 1:	345.6m ²	33%	
House 2:	281.3m ²	30.4%	
House 3:	205.4m ²	21%	
House 4:	186m²	23%	
House 5:	186m²	23%	
House 6:	274.5m ²	16%	
House 7:	280.2m ²	34.6%	
House 8:	266m²	36.4%	
House 9:	317.9m ²	35.9%	
Building Coverage:			
House 1&9:	114.1m ² each		
House 2:	85.4m²		
House 3-6:	43.17m ² each		
House 7&8:	97m ² each		
Total:	680.28m ²	25%	
Parking:	11 bays		
Bicycle Parks:	9 (In Shed)		
Building Setback:	>1.8m		
Road Setback:	3m		
Building Height:	<8m		

Kainga Ora Typology Legend				
Unit Number	Typology	GFA		
House 1	RH.04.08.01 UD	106.5 m ²		
House 2	RC.04.08.01 UD	75.2 m ²		
House 3&4	B.05.01.01	79.55m² per unit		
House 5&6	B.05.01.01	79.55m² per unit		
House 7	RF.04.06.02 UD	81.30 m ²		
House 8	RF.04.06.02 UD	81.30 m ²		
House 9	RH.04.08.01 UD	106.5 m ²		

Hierarchy Group.



NORTH


6-10 Orr Street - AR109526 6-10 Orr Street Netherby Ashburton, 7700

H1259-117

Revision Schedule Description Resource Consent

Building Consent Date | Issue Date: 23/05/24 23/05/24 Drawn By: **KTC** Checked By: MG Sheet **0-11.03** Scale: As indicated @ A1

Bulk and Location Plan - Ground Floor

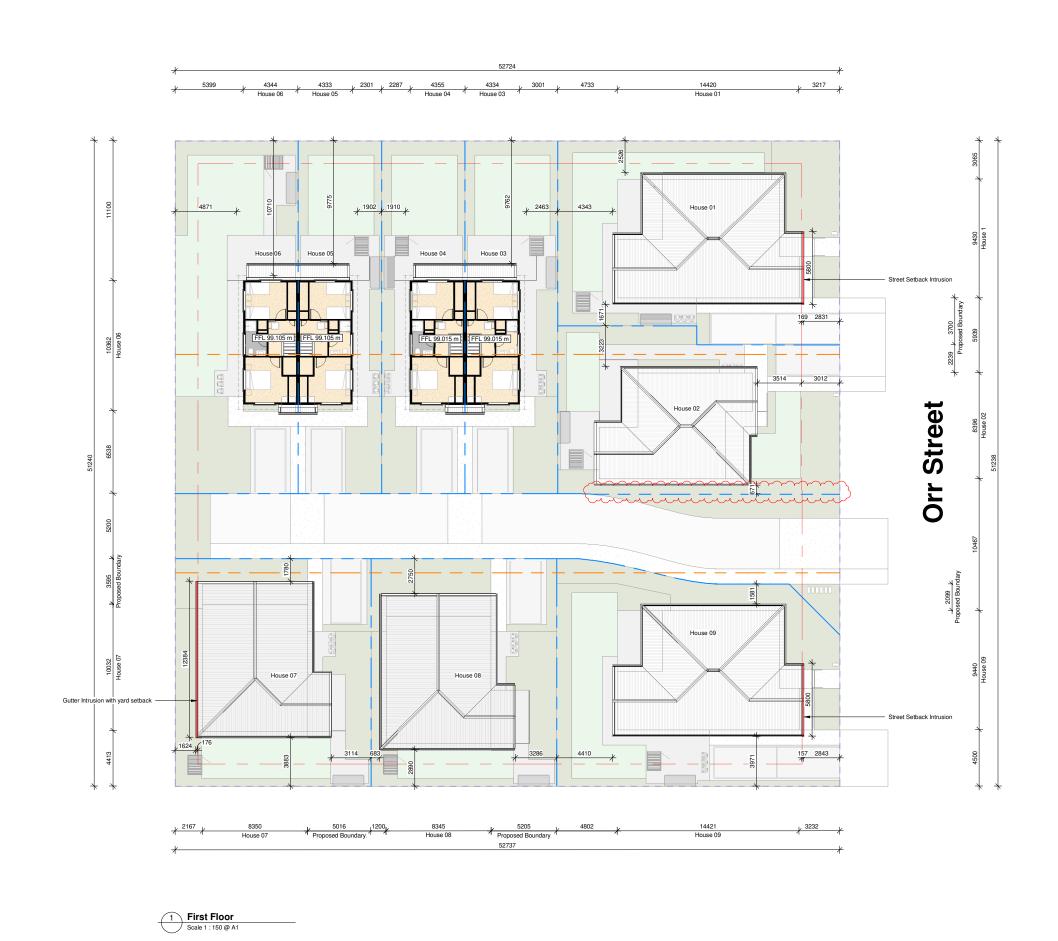

LEGAL DESCRIPTION Lot / DP / CB 3/4/5 / 18886 ZONING INFO:

Wind Region:
Earthquake Zone:
Exposure:
Wind Zone:
Planning Zone:
Flood Management Zone:

GENERAL NOTES

All dimensions are nominal and are to be checked on site before commencing work.

Location of water supply, power & phone to be confirmed

MASTERPLANNING LEGEND	
1 Bedroom House:	
2 Bedroom House:	
3 Bedroom House:	
4 Bedroom House:	
5 Bedroom House:	
Driveway:	
Footpath:	
Lawn Area:	
Landscaping:	
Waste & Recycle Areas:	
Refuse Bins:	
Timber Decking:	
Washlines 1 & 2 Bed: 1,2m above FFL (940mm x 2490mm)	
Washlines >3 Bed: 1,2m above FFL (940mm x 3390mm)	
Letter Boxes:	-
New Water Meters:	WM
Lighting Bollard	+
Small Shed 1 Bed = (1530W x 785D x * For no lawn unit only	1830H mm)
Medium Shed 1 - 4 Bed = (1530W x 10	080D x 1830H mm)

Note: Refer to Boffamiskell drawing set for hard and soft landscaping setout and plant species.

Kainga Ora Typology Legend House 1 RH.04.08.01 UD House 2 RC.04.08.01 UD House 384 B.05.01.01 House 586 B.05.01.01 House 7 RF.04.06.02 UD House 8 RF.04.06.02 UD House 9 RH.04.08.01 UD

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6-10 Orr Street - AR109526 6-10 Orr Street NORTH Netherby Ashburton, 7700


H1259-117


Revision Schedule Description Resource Consent


Resource Consent Date Issue Date: 23/05/2024 23/05/2024 Drawn By: **KTC** Checked By: MG Scale: As indicated @ A1






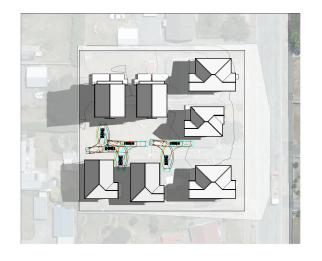

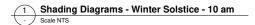


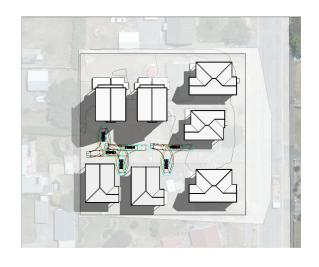


2 Shading Diagrams - Winter Solstice - 12 pm

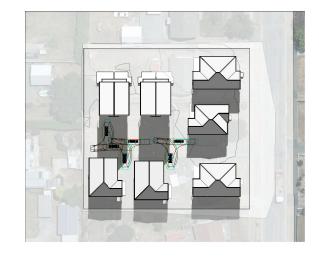


3 Shading Diagrams - Winter Solstice - 3 pm
Scale NTS

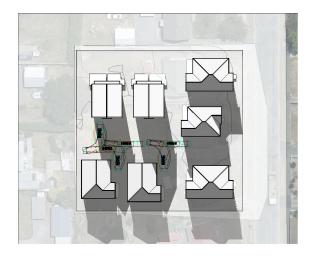

Shading Diagrams - Winter Solstice - 4 pm
Scale NTS

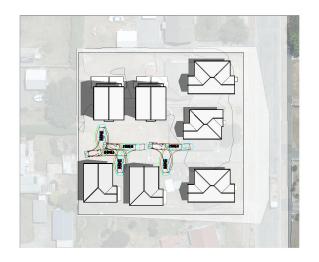


5 Shading Diagrams - Summer Solstice - 10 am
Scale NTS

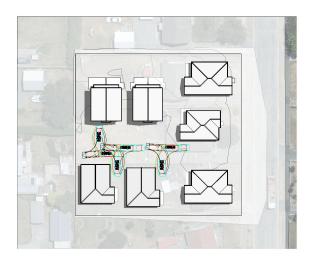

6 Shading Diagrams - Summer Solstice - 12 pm
Scale 1: 600 @ A1




7 Shading Diagrams - Summer Solstice - 3 pm Scale 1: 600 @ A1

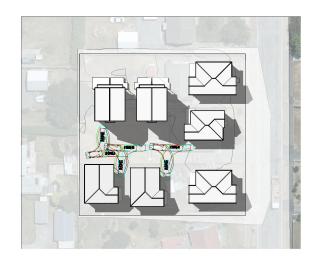

8 Shading Diagrams - Summer Solstice - 5 pm Scale 1:600 @ A1

Scale: 1:600 @ A1




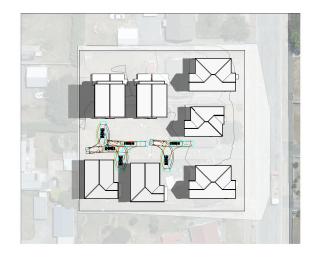


Shading Diagram - Spring Equinox - 10 am
Scale 1:600 @ A1




2 Shading Diagram - Spring Equinox - 12 pm

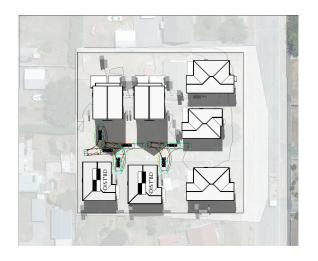


3 Shading Diagram - Spring Equinox - 3 pm

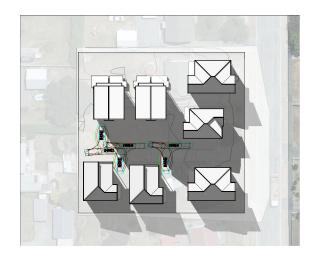


Shading Diagram - Spring Equinox - 5 pm
Scale 1:600 @ A1

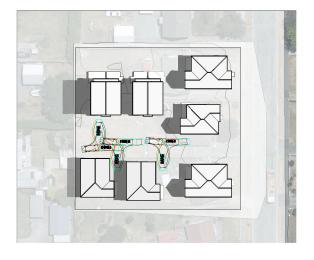

Shading Diagram - Fall Equinox - 10 am
Scale 1: 600 @ A1

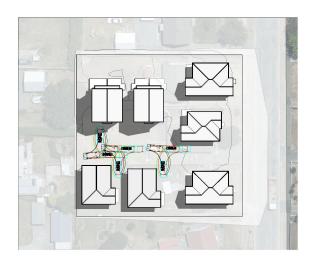

6 Shading Diagram - Fall Equinox - 12 pm

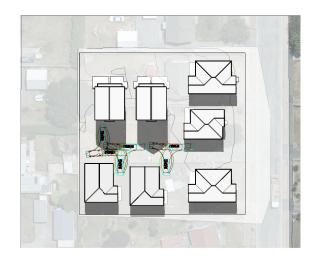

7 Shading Diagram - Fall Equinox - 3 pm Scale 1:600 @ A1



8 Shading Diagram - Fall Equinox - 5 pm
Scale 1:600 @ A1

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6-10 Orr Street - AR109526

6-10 Orr Street Netherby Ashburton, 7700 H1259-117

Revision Schedule Description

Date Issue Date: 19/03/2024

Resource Consent Drawn By: MI Checked By: JW Scale: 1:600 @ A1

Shading Diagrams- Spring & Fall

Sheet No: 0-16.07